PROPOSED MULTI UNIT DEVELOPMENT 140-146 GLENHAVEN RD., GLENHAVEN STORMWATER CONCEPT PLAN

SERVICES NOTES

HYDRAULIC SERVICES NOTES & PROJECT REQUIREMENTS

- THE CONTRACTOR SHALL READ AND FULLY FAMILIARISE THEMSELVES WITH THE HYDRAULIC PLANS, HYDRAULIC SPECIFICATION OF FLOW IN ACCORDANCE WITH AS 2648. DOCUMENTS, AUSTRALIAN STANDARDS, AND AUTHORITY REQUIREMENTS APPLICABLE TO THE WORKS. CLAIMS DUE TO IGNORANCE OF THE CONTENTS OF HYDRAULIC SERVICES DOCUMENTS AND / OR REQUIREMENTS OF AUSTRALIAN STANDARDS /31. TEST ALL SYSTEMS AS REQUIRED BY THE LOCAL AUTHORITIES AND RELEVANT AUSTRALIAN STANDARDS AUTHORITY REQUIREMENTS WILL NOT BE ENTERED INTO.
- THE CONTRACTOR IS REQUIRED TO VISIT AND INSPECT EXISTING SITE STRUCTURES, SERVICES AND CONDITIONS OF THE SITE PRIOR TO MANUFACTURE & INSTALLATION. PRIOR TO SUBMITTING THEIR TENDER AND FAMILIARISE THEMSELVES WITH THE VISIBLE NATURE AND CONDITIONS OF THE SITE ENTERED INTO
- THE HYDRAULIC SERVICES DRAWINGS AND SPECIFICATION SET OUT THE PROJECT REQUIREMENTS TO BE MET OVER AND ABOVE THE MINIMUM STANDARDS AS SET OUT BY THE RELEVANT AUSTRALIAN STANDARD APPLICABLE TO THAT SERVICE. TH CONTRACTOR SHALL MAKE DUE ALLOWANCE IN THEIR TENDER. AND WARRANTS THAT THEY HAVE MADE DUE ALLOWANCE FOR 34 . REQUIREMENTS NECESSARY FOR THE EXECUTION OF THE WORKS IN ACCORDANCE WITH THE STANDARDS AS SET OUT BY FOR THOSE REQUIREMENTS AS SET OUT IN THE HYDRAULIC SERVICES DRAWINGS AND THE ACCOMPANYING SPECIFICATION
- PRAWINGS OF ALL OTHER DISCIPLINES FOR THIS PROJECT. IGNORANCE OF THE CONTENTS OF ANY DOCUMENT RELATIVE TO THE PROJECT SHALL NOT PROVIDE A BASIS FOR ANY VARIATION TO THE CONTRACT.
- PROPOSED SERVICE INSTALLATIONS INDICATED ON THE DRAWINGS.
- 6. ALLOW TO DISCONNECT & SEAL ALL REDUNDANT HYDRAULIC SERVICES RELATED TO THE INSTALLATION OF THE RELEVANT AUSTRALIAN STANDARDS. PROPOSED WORKS TO THE REQUIREMENTS OF THE RELEVANT AUTHORITY.
- 7. ALL WORK BE CARRIED OUT IN ACCORDANCE WITH WATER & SEWER AUTHORITY REGULATIONS. SUPERINTENDENTS
- 8. LOCATION OF FIXTURES SHALL BE IN ACCORDANCE WITH LATEST ARCHITECTURAL DRAWINGS. 9. WIRING OF HWU/S AND GPO/S FOR BOILING / CHILLED WATER UNIT BY ELECTRICAL CONTRACTOR.
- 10. LIAISE WITH BUILDING SUPERINTENDENT TO ARRANGE SHUTDOWN AND ASSOCIATED WORKS.
- 11. ALL PIPES FIXTURES & FITTINGS ARE TO BE FIRST QUALITY AND OF ONE MANUFACTURER. WRITTEN WARRANTIES ON INSPECTION BY THE SUPERINTENDENT. ALL TO BE VANDAL PROOF.
- 12. ALL FIXTURES ARE TO BE SUPPLIED AND INSTALLED BY THE HYDRAULICS SERVICES CONTRACTOR UNLESS SPECIFIED42. THE CONTRACTOR SHALL ALLOW FOR AND PAY ALL FEES AND OBTAIN ALL AUTHORITY CLEARANCES INCLUDING OTHERWISE
- NECESSARY.
- DAMAGE.
- SERVICES PLUS ANY RELEVANT AUSTRALIAN STANDARDS. 16. ALL MATERIALS USED IN THE WORK SHALL BE NEW AND OF THE BEST QUALITY AND TYPE AVAILABLE TO CONFORM STANDARDS. WITH THE RELEVANT AUSTRALIAN STANDARDS AND BEAR THE REQUIRED STANDARDS MARK.
- 17. FOR ALL PLUMBING AND DRAINAGE WORKS, AN APPLICATION SHALL BE LODGED AS REQUIRED BY THE SYDNEY VERIFIED ON SITE PRIOR TO COMMENCEMENT OF WORK. WATER REGULATION 2000 SECTION 7 UNDER THE SYDNEY WATER ACT 1994. UPON COMPLETION, THE PLUMBER CARRYING OUT THE WORK SHALL SUBMIT TO THE PROJECT MANAGER THE SIGNED ORIGINAL OWNER'S COPY OF THE48. REUSED DRAINS UNDER BUILDINGS SHALL BE RETESTED WHERE DIRECTED BY SUPERINTENDENT. CERTIFICATE OF COMPLIANCE.
- 18. ANY DAMAGE TO SERVICES DURING CONSTRUCTION SHALL REPAIRED IMMEDIATELY AT THE CONTRACTORS OWN 49.1. THE PROPERTY BOUNDARY EXPENSE.
- 19. REFER TO SPECIFICATION FOR ADDITIONAL SPECIFICATION NOTES, WORK INSTRUCTIONS, MATERIAL SPECIFICATIONS 49.4. IMMEDIATELY UPSTREAM & DOWNSTREAM OF ALL JUMP-UPS & STANDARDS.
- 20. PIPE WORK SHALL BE CAPPED OFF AS WORK PROCEEDS TO PREVENT INGRESS OF DIRT, CONCRETE ETC. USE50. ALL SERVICES THAT CROSS PAVEMENTS, FOOTING ETC SHALL BE BACKFILLED WITH GRANULAR MATERIAL TO PROPRIETARY CAPS / PLUGS.
- DRAINAGE WORKS AND FOR ALL SYDNEY WATER INSPECTIONS.
- 22. PIPING SHOWN FOR CLARITY ONLY, ACTUAL POSITION TO BE DETERMINED AND COORDINATED ON SITE. 23. ALL LEVELS AND DIMENSIONS SHOWN TO BE CHECKED ON SITE PRIOR TO COMMENCING ANY WORKS. REPORT ANY DISCREPANCIES TO THE SUPERINTENDENT.
- 24. HYDRAULIC DRAWINGS TO BE READ IN CONJUNCTION WITH ARCHITECTURAL AND ENGINEERING DRAWINGS.
- 25. COORDINATE SERVICES WITH ALL OTHER TRADES AND WORKS ON SITE. THOROUGHLY INVESTIGATE THE EXTENT OF EXISTING SERVICES PRIOR TO COMMENCING WORKS ON SITE. 26. DURING THE INSTALLATION, RECORD ALL CHANGES TO THE DESIGN DRAWINGS AND DIMENSION OF HIDDEN SERVICES
- INSTALLED DRAWINGS AND ELECTRONIC FILES IN AUTOCAD DWG FORMAT ON CD. 27. PROVIDE THREE (3) SETS OF OPERATION AND MAINTENANCE MANUALS FOR ALL SYSTEMS. THE MANUALS SHALI
- INCLUDE A BRIEF DESCRIPTION OF EACH SERVICE AND DETAILS OF ALL EQUIPMENT WARRANTIES AND MAINTENANCE PROCEDURES ASSOCIATED WITH THAT SERVICE. THE AS INSTALLED DRAWINGS AND ELECTRONIC FILES ARE TO BE INCLUDED IN THE MANUALS
- 28. ALL PIPEWORK AND ASSOCIATED VALVES AND EQUIPMENT WHICH ARE TO BE INSTALLED IN EXISTING BUILDING/S AND PENETRATING THROUGH EXISTING STRUCTURE ARE TO BE APPROVED BY THE SUPERINTENDENT PRIOR TO COMMENCEMENT OF WORKS.
- 29. FIT ALL SLEEVES AND FIRE COLLARS WHERE NECESSARY FOR PIPES PASSING THROUGH FIRE RATED STRUCTURE. PIPEWORK SHALL BE HIDDEN FROM VIEW BY INSTALLATION IN WALLS, CEILINGS OR BURYING IN GROUND. WHERE PIPEWORK CANNOT BE HIDDEN FROM VIEW, OBTAIN APPROVAL FROM THE SUPERINTENDENT PRIOR TO INSTALLATION.

30 EXPOSED PIPEWORK SHALL BE PAINTED AND LABELLED WITH PIPE MARKERS IN ACCORDANCE WITH AS 1345 PIPEWORK IN GROUND SHALL BE PROVIDED WITH MARKING TAPE IN THE TRENCH INDICATING THE SERVICE AND 32. ALLOW TO CO-ORDINATE FINAL LOCATIONS OF ALL PIPEWORK & EQUIPMENT WITH STRUCTURE & OTHER SERVICE RELATIVE TO THE WORKS TO BE CARRIED OUT. CLAIMS DUE TO IGNORANCE OF EXISTING SITE CONDITIONS WILL NOT BE33. ALLOW TO ACOUSTICALLY INSULATE ALL SANITARY & STORM WATER DRAINAGE INSTALLED IN ABOVE SOUND SENSITIVE AREAS ie. BEDROOMS, LIVING AREAS IN ACCORDANCE WITH THE BCA OR THE ACOUSTIC REPORT IF AVAILABLE UNLESS OTHERWISE SPECIFIED, CORE HOLES ARE TO BE SLAB SEAL OR SIMILAR HE RELEVANT AUSTRALIAN STANDARD APPLICABLE TO THAT SERVICE, THE RELEVANT LOCAL AUTHORITY REQUIREMENTS AND 35. WHERE PASSING THROUGH ROOF THE PIPES SHALL BE FLASHED IN AN APPROVED MANNER LEAVING THE ROOF WATER TIGHT. UNLESS OTHERWISE SPECIFIED ON NON-TRAFFICABLE ROOFS THE VENT SHALL TERMINATE A MINIMUM HYDRAULIC SERVICES DRAWINGS ARE TO BE READ IN CONJUNCTION WITH HYDRAULIC SERVICES SPECIFICATION AND OF 300mm ABOVE ROOF AND ON TRAFFICABLE ROOFS THE VENTS SHALL TERMINATE 3000mm ABOVE ROOF. 36. REFER TO ARCHITECTS PLANS FOR EXACT LOCATION & SET OUT OF PLUMBING FIXTURES & FITTINGS 5. ALLOW TO OBTAIN ALL APPROVALS AND PAY ALL FEES AND CHARGES TO ALL AUTHORITIES IN RELATION TO THE37. ALL WORK SHALL BE CARRIED OUT BY AND UNDER THE SUPERVISION OF A LICENSED PLUMBER IN STRICT CONFORMITY WITH THE ARCHITECTURAL PLANS, HYDRAULIC DRAWINGS AND SPECIFICATIONS AND IN ACCORDANCE WITH THE REQUIREMENTS OF THE BUILDING CODE OF AUSTRALIA, LOCAL AUTHORITIES, AS 3500 AND OTHER 38. WORK IS TO BE CARRIED OUT TO THE SATISFACTION OF THE PROJECT MANAGER. SERVICES HAVE BEEN PLOTTED FROM SUPPLIED DATA THE SUPERINTENDENT DOES NOT GUARANTEE THEIR ACCURACY. IT IS THE CONTRACTOR'S RESPONSIBILITY TO ESTABLISH THE LOCATION OF ALL EXISTING SERVICES PRIOR TO COMMENCING WORK. 40. UPON SIGNING THE CONTRACT, THE CONTRACTOR IS DEEMED TO HAVE VISITED SITE AND FAMILIARISED THEMSELVES WITH THE SITE, THE LOCATIONS & SIZES OF ALL EXISTING SERVICES AND THE EXTENT OF WORKS REQUIRED TO PROVIDE A COMPLETE. WORKING AND SERVICEABLE INSTALLATION BASED ON THE DRAWINGS, AND SITE CONSTRAINTS. VARIATIONS DUE TO OBVIOUS SITE CONSTRAINTS WILL NOT BE APPROVED. WORKMANSHIP AND MATERIALS OF AT LEAST 1 YEAR REQUIRED FOR EACH UNIT. ALL UNITS SHALL BE SUBJECT TO41. HYDRAULIC SERVICES CONTRACTOR SHALL PROVIDE A CERTIFICATE OF COMPLIANCE UPON COMPLETION OF WORKS FOR ALL SERVICES INSTALLED SYDNEY WATER, COUNCIL AND GAS COMPANY 13. ON COMPLETION OF THE INSTALLATION ALLOW TO TEST THE FIXTURES FOR NORMAL OPERATION AND ADJUST AS43. ALL PIPE PENETRATIONS AT WALLS SHALL BE FITTED WITH A PUDDLE FLANGE AND ALL WALL PENETRATIONS SHALL BE MADE GOOD AND WATER TIGHT. 14. ALL FIXINGS SHALL BE PLUMB AND LEVEL AND NEATLY FINISHED IN A TRADESMAN LIKE MANNER AND WITHOUT44. PRESSURE PIPE 'BLUE BRUTE' CLASS 20 TO AS 2977 WITH RUBBER RING JOINTS AND DUCTILE IRON FITTINGS EXCEPT WHERE PIPEWORK RUNS UNDERSIDE OF THE BUILDING 15. PROVIDE ALL MATERIALS AND LABOUR NECESSARY TO PROVIDE A COMPLETE, WORKING AND SERVICEABLE45. CAP OFF ALL REDUNDANT SERVICES AT THE AUTHORITY MAIN. ARRANGE INSPECTION WITH THE AUTHORITY PRIOR TO INSTALLATION BASED ON THE DRAWINGS, SPECIFICATION COORDINATION WITH THE STRUCTURE AND OTHER BACK FILLING AND MAKING GOOD THE SURFACE. PAY ALL ASSOCIATED FEES AND CHARGES. 46. PROVIDE APPROVED FIRE STOP COLLARS TO THE REQUIREMENTS OF THE BCA AND RELEVANT AUSTRALIAN 47. DRAINS TO BE SUPPORTED ON OR FROM SOLID GROUND. LOCATION & DEPTH / INVERT LEVEL OF BRANCH SHALL BE 49. INSPECTION OPENINGS SHALL BE PROVIDED AT: 49.2. ON EACH WC OR BRANCH 49.3. AT MAX. 30m INTERVALS SPREAD EQUIDISTANT WHERE POSSIBLE 49.5. AS REQUIRED BY THE AUTHORITY FOR INSPECTION & MAINTENANCE SUBGRADE LEVEL & COMPACTED TO 95% M.M.D.D. 21. ALLOW TO MAKE APPLICATION & PAY ALL FEES TO SYDNEY WATER TO OBTAIN A PERMIT TO UNDERTAKE PLUMBING &51. PROVIDE 80mm COMPRESSIBLE MATERIAL OVER PIPEWORK WHERE CLEARANCE TO UNDERSIDE OF FOOTING IS LESS THAN 150mm UNLESS NOTED OTHERWISE. 52. ON COMPLETION OF PIPE INSTALLATION, ALL DISTURBED AREAS MUST BE RESTORED TO ORIGINAL CONDITION INCLUDING: KERBS, FOOTPATH.CONCRETE AREAS, GRAVEL AREAS & ROAD PAVEMENTS. 53. CARE SHALL BE TAKEN WHEN EXCAVATING NEAR EXISTING SERVICES. NO MECHANICAL EXCAVATION SHALL BE MADE OVER AUTHORITY SERVICES, TELSTRA OR ELECTRICAL SERVICES. EXCAVATE BY HAND IN THESE AREAS. 54. THE PLUMBING CONTRACTOR SHALL OBTAIN ALL AUTHORITY APPROVALS & PAY ALL FEES. 55. INVERT LEVELS SHOWN ARE INDICATIVE ONLY. CONFIRM ALL LEVELS ON SITE BEFORE COMMENCING INSTALLATION WORK FROM PERMANENT, VISIBLE LANDMARKS. AT THE COMPLETION OF THE WORKS PROVIDE THREE (3) SETS OF AS56. ACCESS PANEL ARE TO BE INSTALLED WHERE REQUIRED TO ACCESS CONTROL VALVES IN WATER LINES AS REQUIRED & INSPECTION OPENINGS ON STORMWATER & SEWER RISERS. ACCESS PANELS SHALL MATCH PROPOSED FINISH. REFER TO ARCHITECTURAL DRAWING FOR FINISHES. Note Allow to obtain approval and pay all fees and charges to all authorities in relation to the

- proposed service installations as indicated on the drawings.
- Allow to provide " as-built " drawings on Autocad dwg compatible file format together with 2-off paper copies before final payment.
- Services shown on this plan have been plotted from plans and by field These services and others that may exist may not be situated within registered easements or within standard footpath allocations.
- It is the contractors responsibility to identify the locations of all services via electronic pipe locating prior to **ANY** construction works and to avoid disturbance of these services. Allow to disconnect & cap off obsolete services at authority mains.
- Contractor to provide work as executed plan prepared by a registered surveyor & provide
- certification that the stormwater drainage & detention system has been installed as per approved plans.

Council Amendments		СНІТІ
DA Submission		
Preliminary	SYDNEY	М
NOTATION/AMENDMENT		101

DO NOT SCALE DRAWINGS. CHECK ALL DIMENSIONS ON SITE. FIGURED DIMENSIONS TAKE PRECEDENCE

C Aug.2017

B Apr.2017

REV DATE

A Nov 2016


612-9922-2344

PROJECT ARCHITECT

IELBOURNE 613-8676-0427

Existing services are located within the site for which documentation is not available.

PIPELINE SYMBOL LEGEND

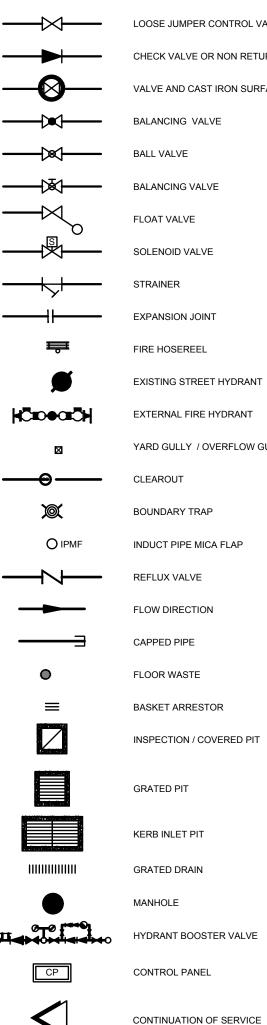

LOOSE JUMPER CONTROL VALVE CHECK VALVE OR NON RETURN VALVE VALVE AND CAST IRON SURFACE BOX BALANCING VALVE BALL VALVE BALANCING VALVE FLOAT VALVE SOLENOID VALVE EXPANSION JOIN FIRE HOSEREEI EXISTING STREET HYDRANT EXTERNAL FIRE HYDRANT YARD GULLY / OVERFLOW GULLY CLEAROU BOUNDARY TRAP INDUCT PIPE MICA FLAP REFLUX VALVE FLOW DIRECTION CAPPED PIPE FLOOR WASTE BASKET ARRESTOR **INSPECTION / COVERED PIT** GRATED PIT

FLOOR WASTE RAINWATER OUTLET WM GM GM

CIRCULATING PUMP PRESSURE LIMITING VALVE WATER METER HOT WATER METER GAS METER SERVICE RISER / DROPPER HOSE TAP

OVERFLOW RELIEF GULLY


CHECK VALVE/REFLUX VALVE OR NON RETURN VALVE. TRAP PRIMING VALVE

TUNDIS



CLIENT

HYDRAULIC CONSULTANT

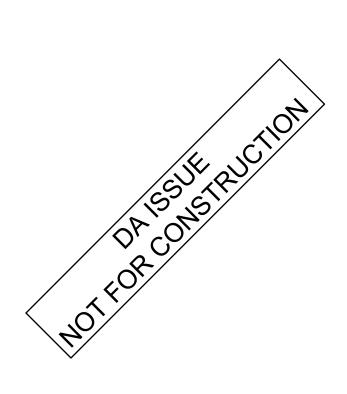

EXISTING STORMWATER DRAINAGE

AIR ADMITTANCE VALVE

ENWARE CSQ343 SHROUDED HOSETAP RECESSED IN WALL TRAPPED TUNDISH

WINDOW DRENCHER HEAD 93°c TEMPERATURE RATING

BACKFLOW PREVENTION DEVICE

PRESSURE REDUCING VALVE

THERMOSTATIC MIXING VALVE

SERVICE LEGEND


	EXISTING SEWER DRAINAGE/SANITARY PLUMBING
· · · · ·	EXISTING COLD WATER SERVICE
· ·	EXISTING HOT WATER SUPPLY
· · · · · · · · · ·	EXISTING GAS SERVICE
	EXISTING FIRE HYDRANT SERVICE
	EXISTING FIRE HOSEREEL SERVICE
	STORMWATER DRAINAGE
	SEWER DRAINAGE/SANITARY PLUMBING
· · · · · ·	COLD WATER SERVICE
· · · · · · · · · · · ·	RAINWATER / RECYCLED WATER REUSE SERVICE
· · · · · · · · · · ·	HOT WATER SUPPLY
· · · · · · · · · · · ·	HOT WATER RETURN
· · · · · · · · · · ·	WARM WATER SERVICE
· · · · · · · ·	GAS SERVICE
	FIRE HYDRANT SERVICE
	FIRE HOSEREEL SERVICE
	VENT PIPING
	TUNDISH DRAINAGE SERVICE
<u> </u>	SILT FENCE
	DENOTES EXISTING PAVED AREA TO BE SAWCUT A


EXISTING SERVICES NOTES


- 1. SERVICES SHOWN ON HYDRAULIC PLANS HAVE BEEN PLOTTED FROM PLANS AND BY FIELD INSPECTION. THESE SERVICES AND OTHERS MAY NOT BE SITUATED WITHIN REGISTERED EASEMENTS OR WITHIN STANDARD FOOTPATH ALLOCATIONS. IT IS THE CONTRACTORS RESPONSIBILITY TO IDENTIFY THE LOCATIONS OF ALL SERVICES PRIOR TO CONSTRUCTION WORKS AND TO AVOID DISTURBANCE OF THESE SERVICES. THE CONTRACTOR IS ADVISED TO CONTACT THE 'DIAL BEFORE' YOU DIG' SERVICE TO ASCERTAIN THE LOCATIONS OF ANY EXISTING AUTHORITY SERVICES.
- 2. THE HYDRAULIC SUBCONTRACTOR SHALL ENSURE THAT AT ALL TIMES SERVICES TO ALL BUILDINGS NOT AFFECTED BY THE WORKS ARE NOT DISRUPTED. PRIOR TO COMMENCEMENT OF ANY WORKS THE CONTRACTOR SHALL GAIN APPROVAL OF THEIR PROGRAMME FOR THE RELOCATION/CONSTRUCTION OF TEMPORARY SERVICES.
- 3. HYDRAULIC SUBCONTRACTOR SHALL ALLOW TO CONSTRUCT NECESSARY SERVICES TO MAINTAIN SUPPLY TO EXISTING BUILDINGS REQUIRED TO REMAIN IN OPERATION TO THE SATISFACTION AND APPROVAL OF THE SUPERINTENDENT. ONCE DIVERSION IS IS COMPLETE AND COMMISSIONED THE CONTRACTOR SHALL ALLOW TO REMOVE ALL TEMPORARY SERVICES AND MAKE GOOD TO THE SATISFACTION OF THE SUPERINTENDENT.
- 4. INTERRUPTION TO SUPPLY OF EXISTING SERVICES SHALL BE DONE SO AS NOT TO CAUSE ANY INCONVENIENCE TO THE PRINCIPAL. CONTRACTOR TO GAIN APPROVAL OF SUPERINTENDENT FOR TIME OF INTERRUPTION.


Note Hydraulic design plans to be read in conjunction with architectural plans

PROPOSED MULTI DWELLING DEVELOPMENT at 140-146 GLENHAVEN RD.,	STORMWATER CONCEP	T PLAN FES	DATE: NOV 16	VISSION SCALE: nts@A1 DRAWN: SB	PROJ: CHECKED: RB
GLENHAVEN, NSW	FILE:	PLOTTED:	SHEET:	H-01	1

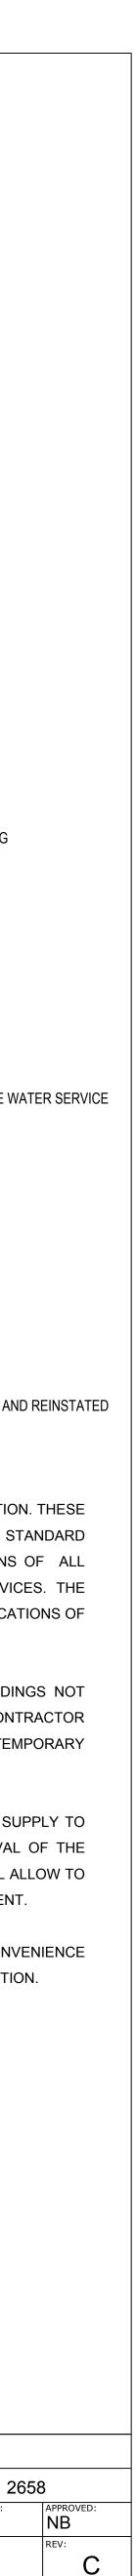

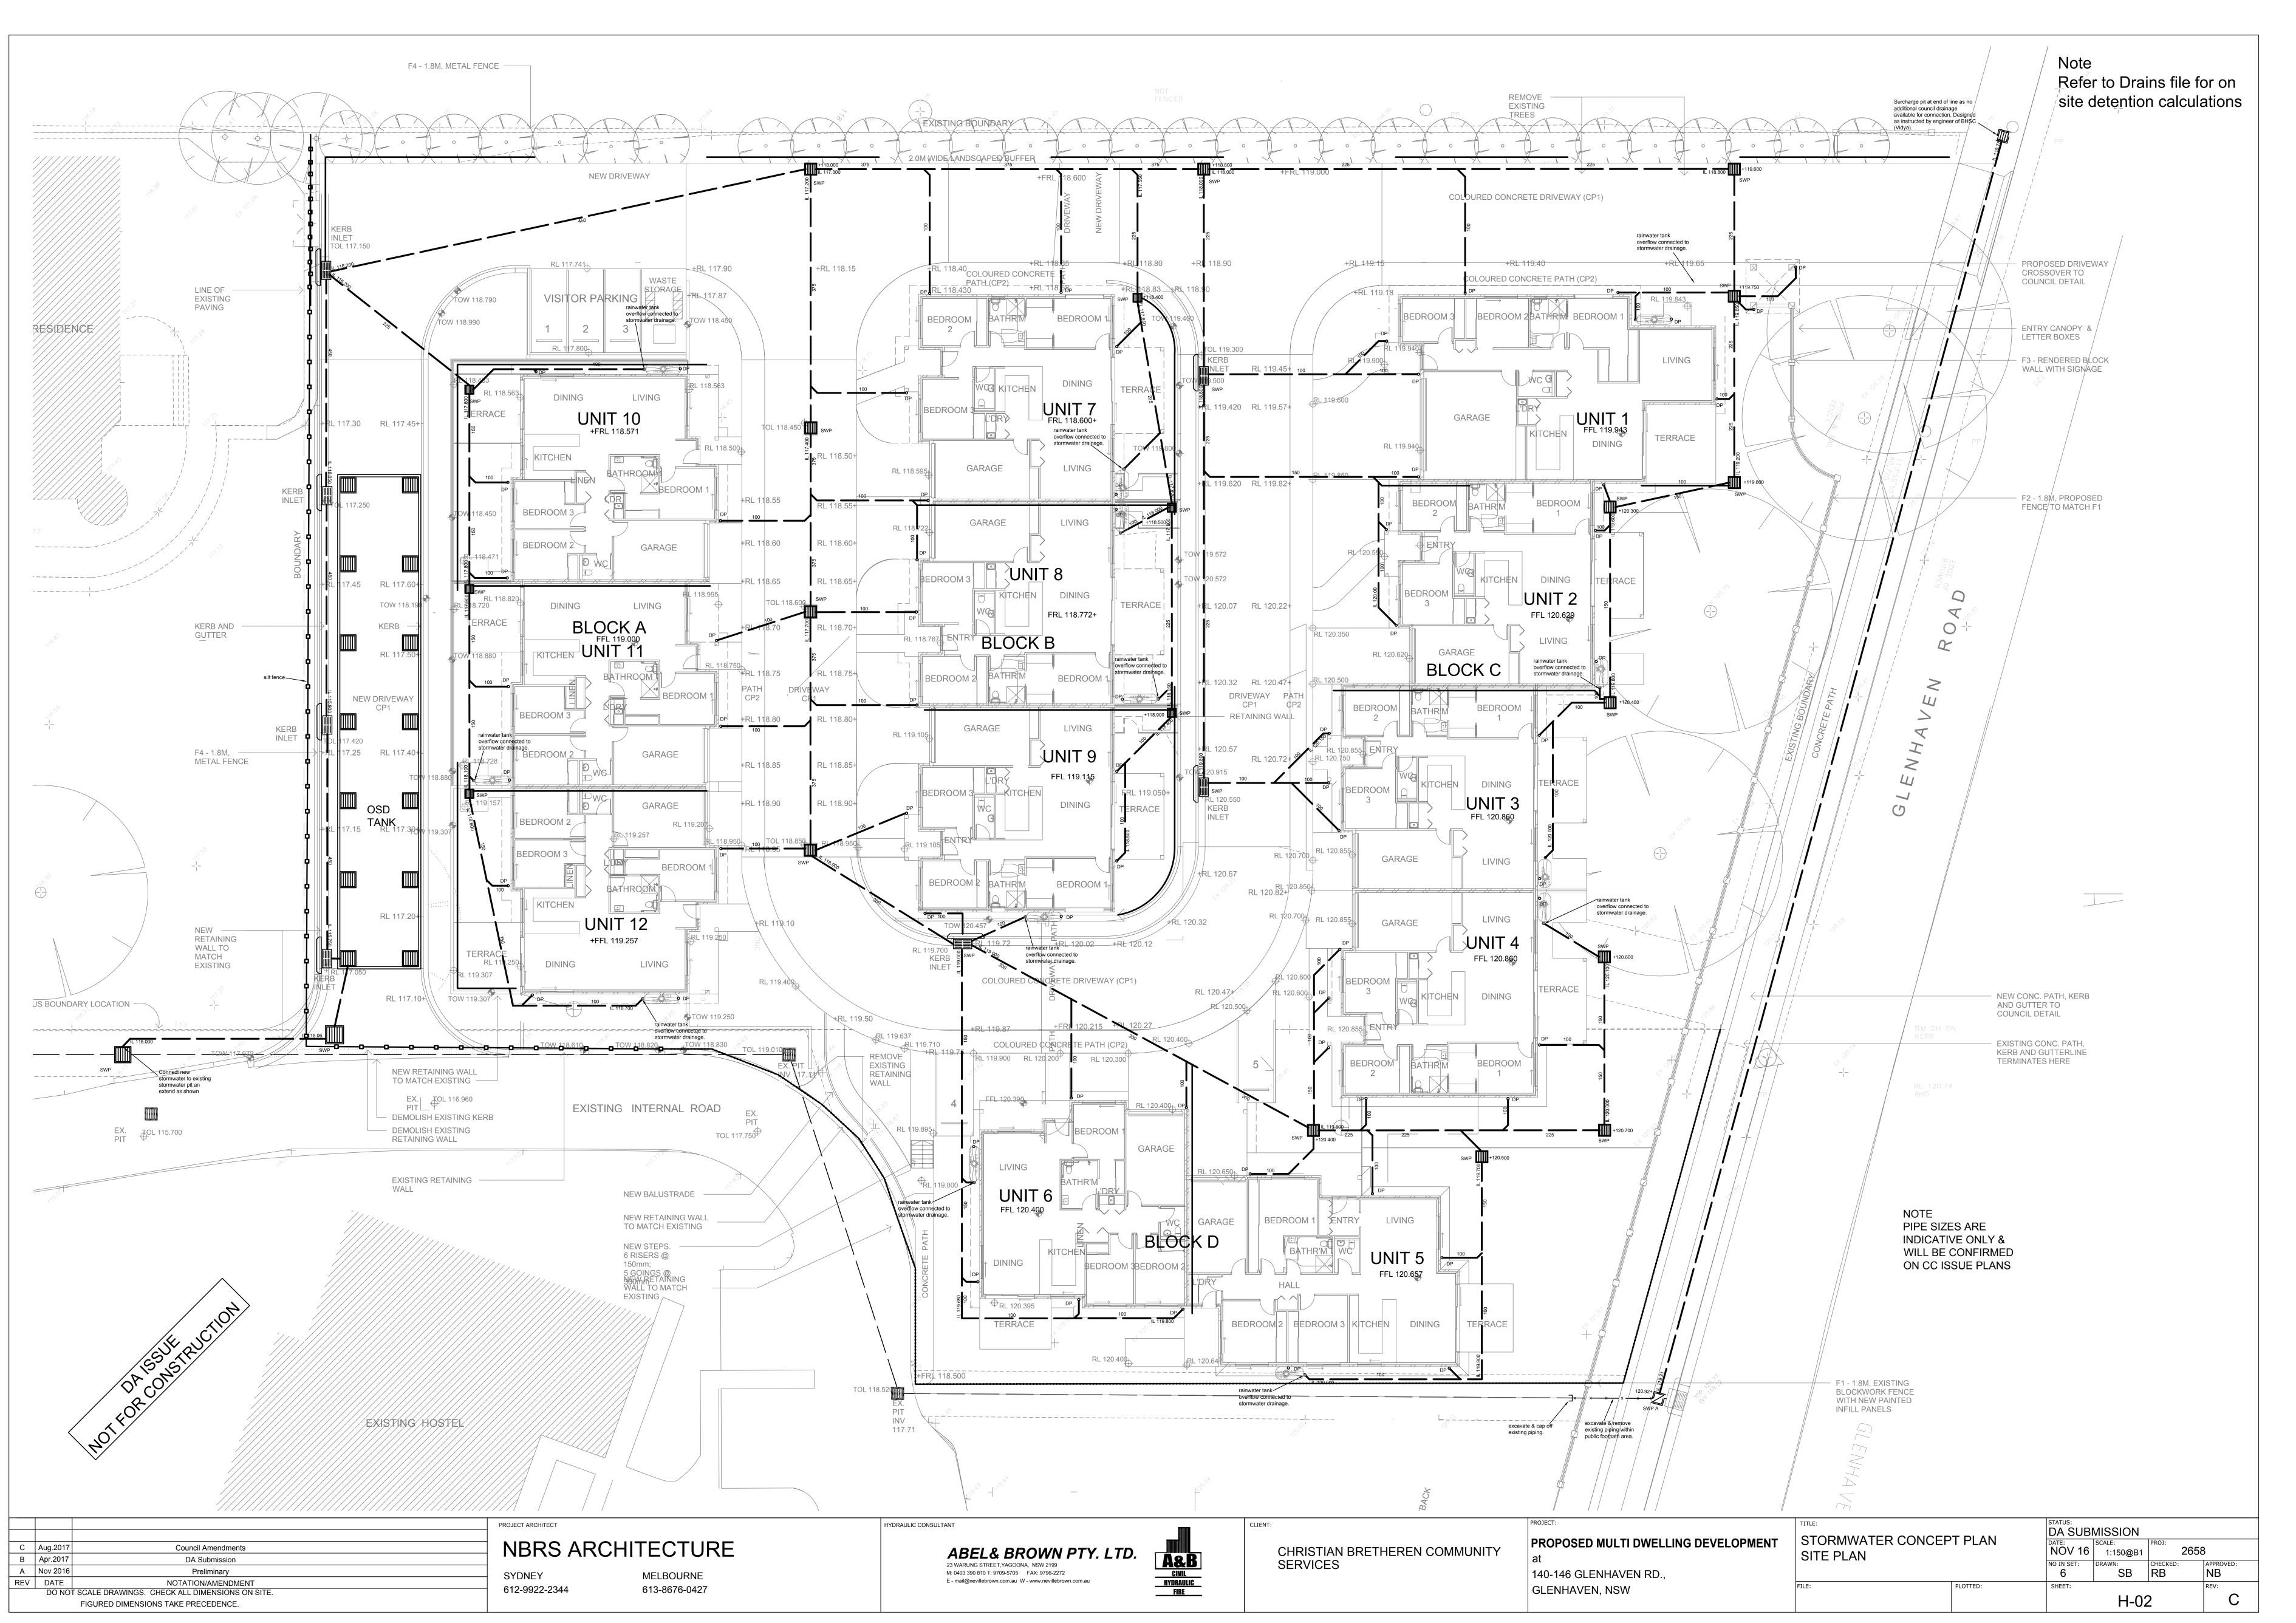

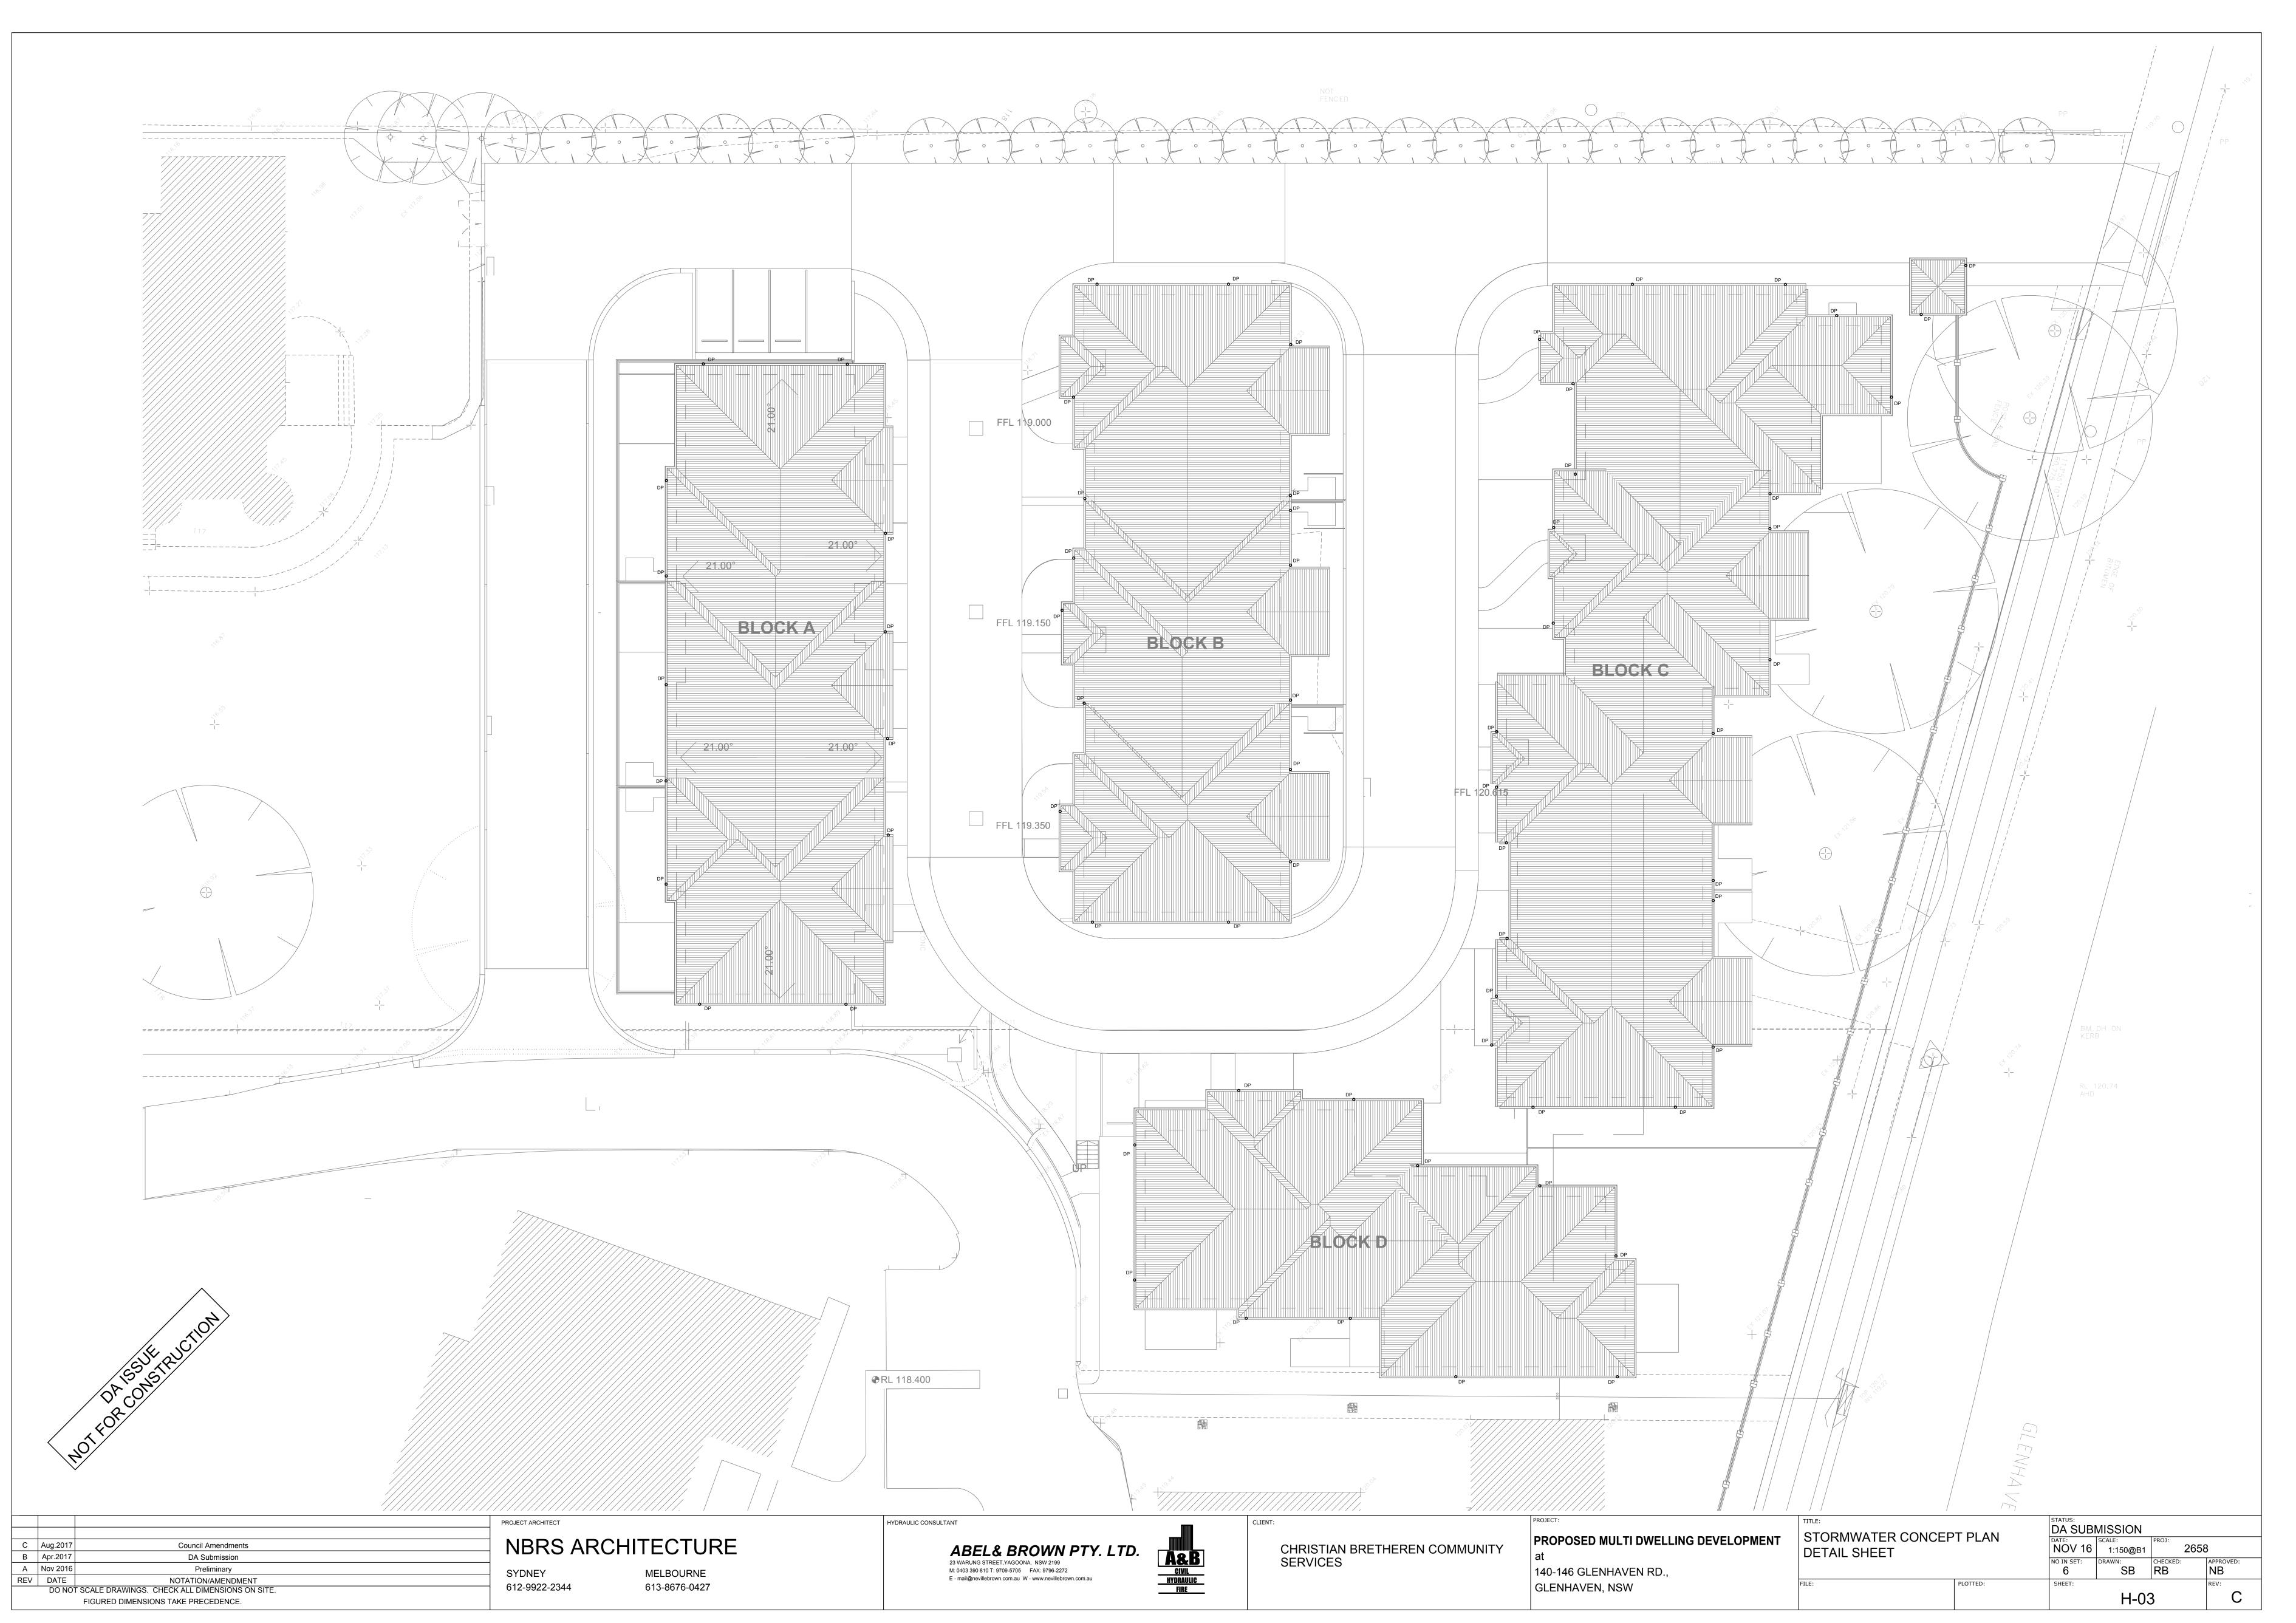

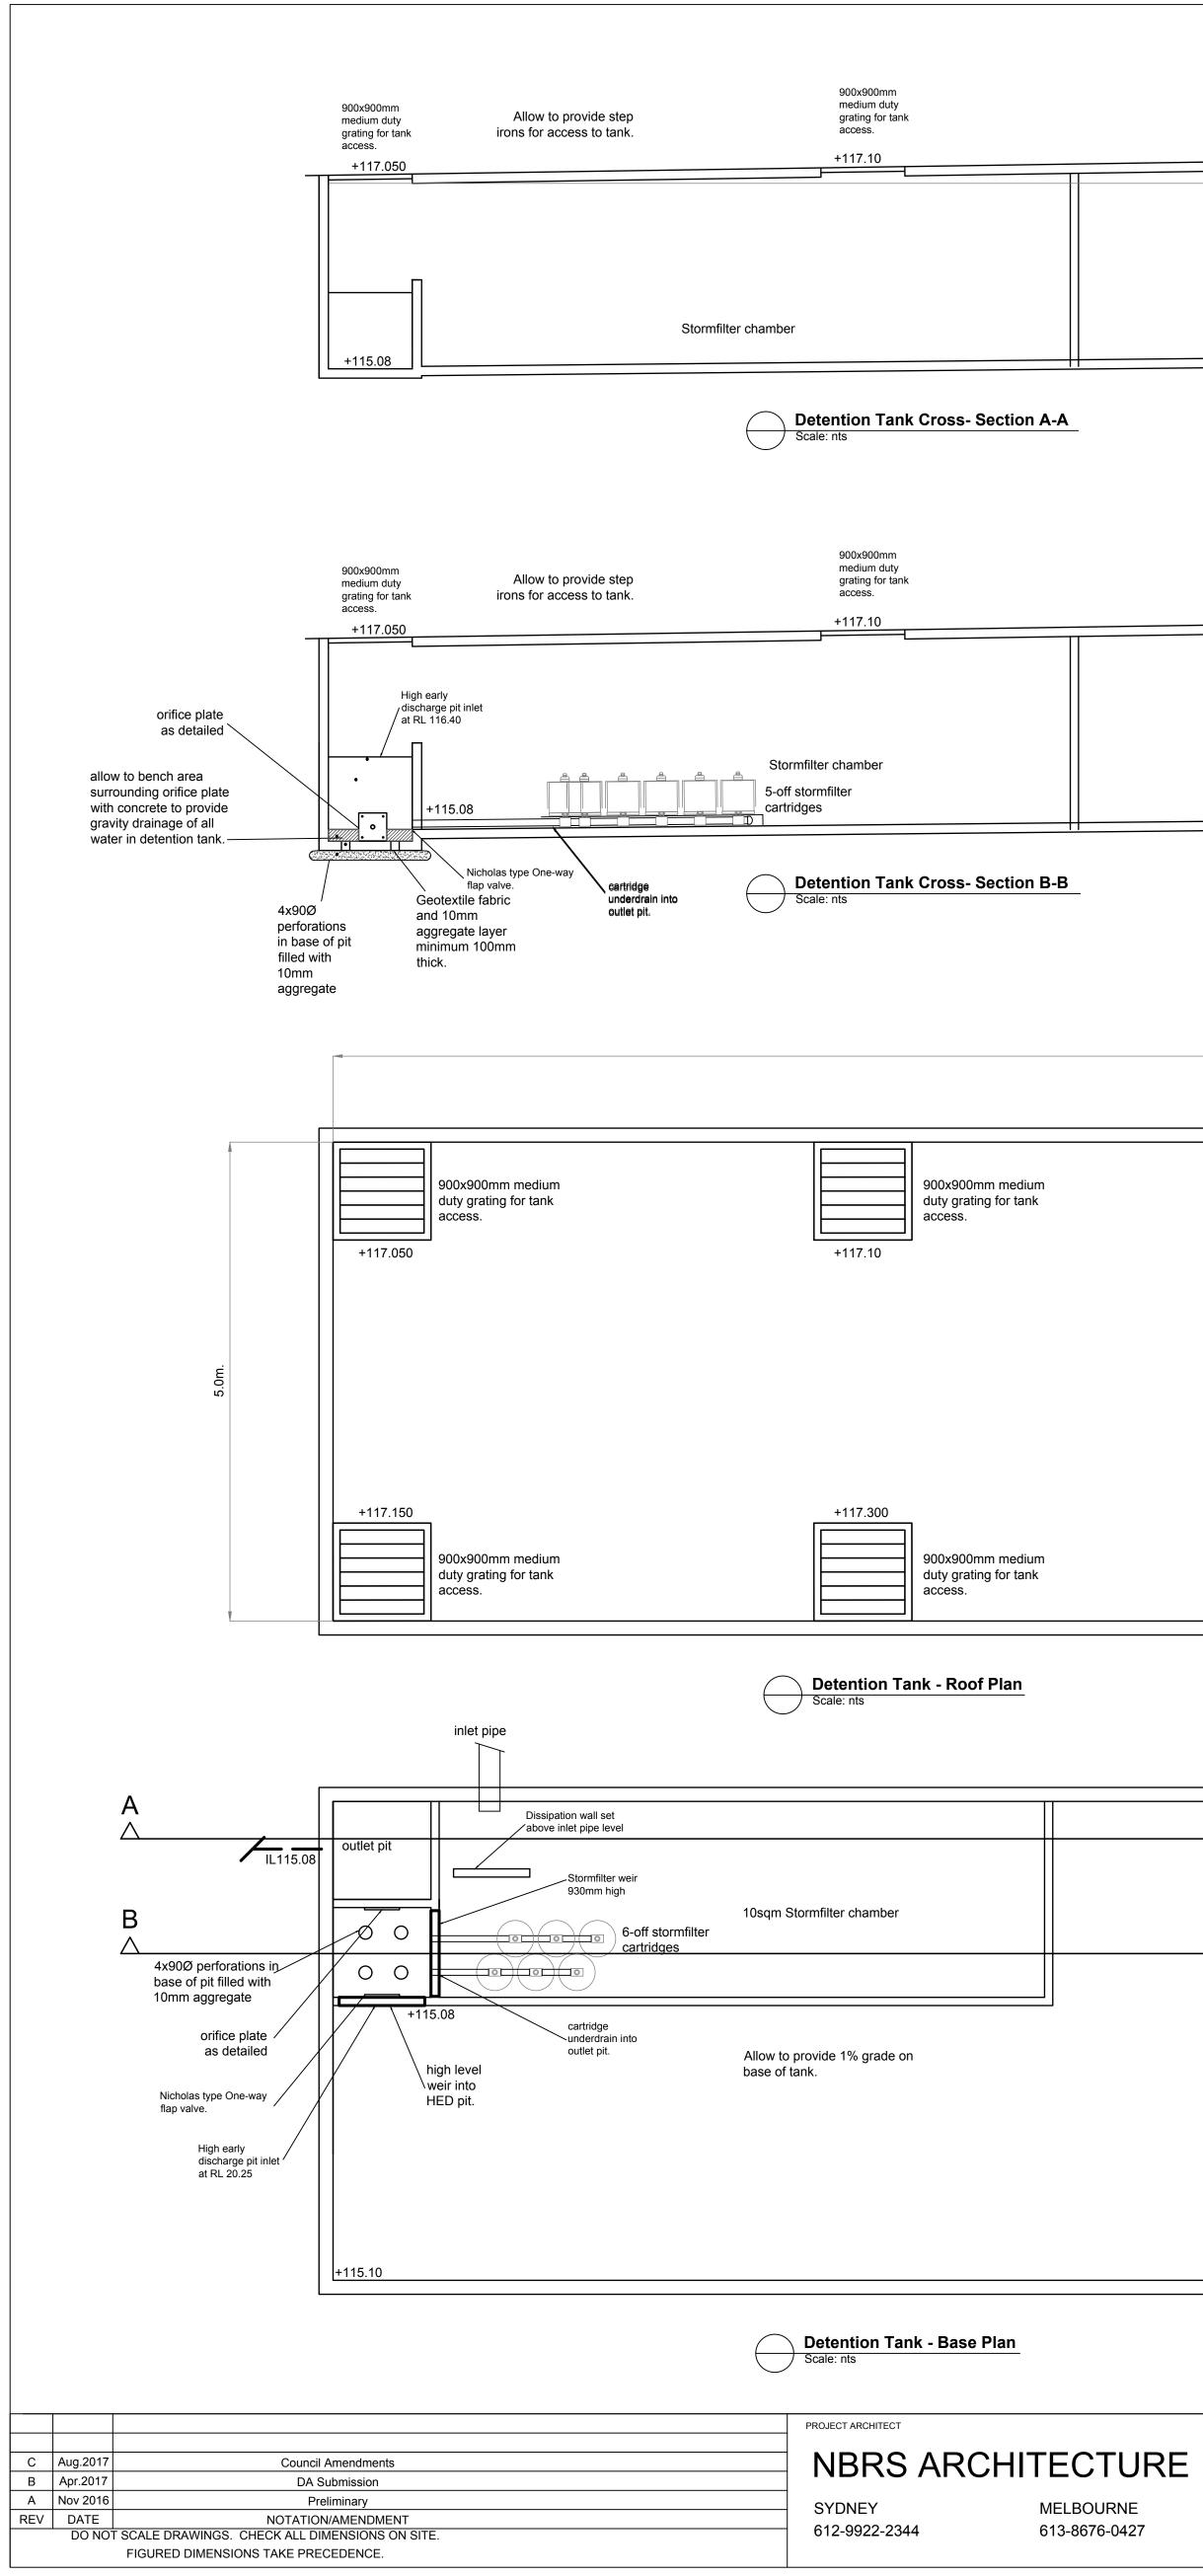

900x900mm medium duty grating for tan access. +117.150	900x900mm medium duty grating for tank access. +117.250		900x900mm medium duty grating for tank access. +117.350
		AVE. DEPTH - 1.610	
	115.240+	•	

900x900mm medium duty grating for tank access.	900x900mm medium duty grating for tank access.	900x900mm medium duty grating for tank access.
	+117.250	+117.350
+117.150		

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duty grating for tank duty grating for tank duty grating for tank	+117.300		+117.400		+117.500	
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Refer to structural engineer's drawings for tank construction details.


HYDRAULIC CONSULTANT ABEL& BROWN PTY. LTD. 23 WARUNG STREET, YAGOONA, NSW 2199

M: 0403 390 810 T: 9709-5705 FAX: 9796-2272


E - mail@nevillebrown.com.au W - www.nevillebrown.com.au




CLIENT:

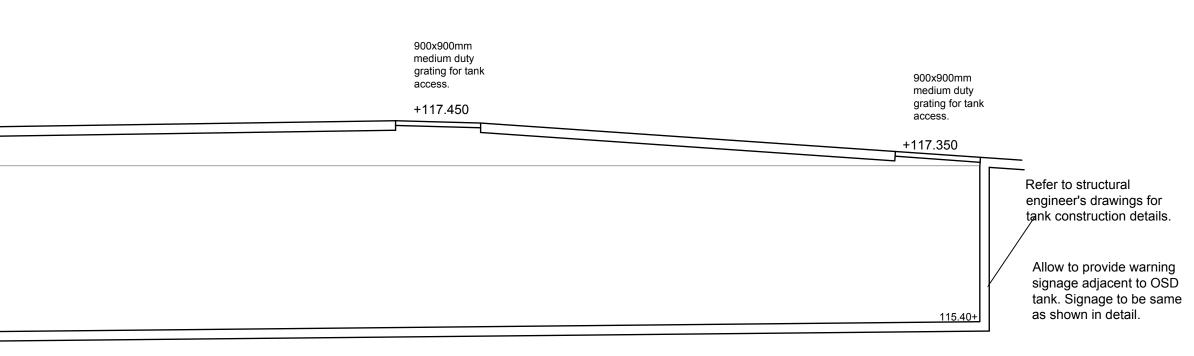

Allow to provide 1% grade on base of tank.

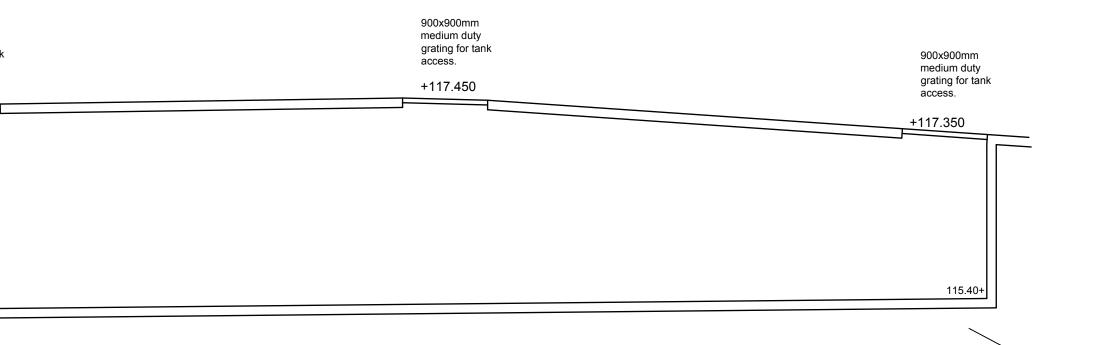



Allow to provide 1% grade on base of tank.

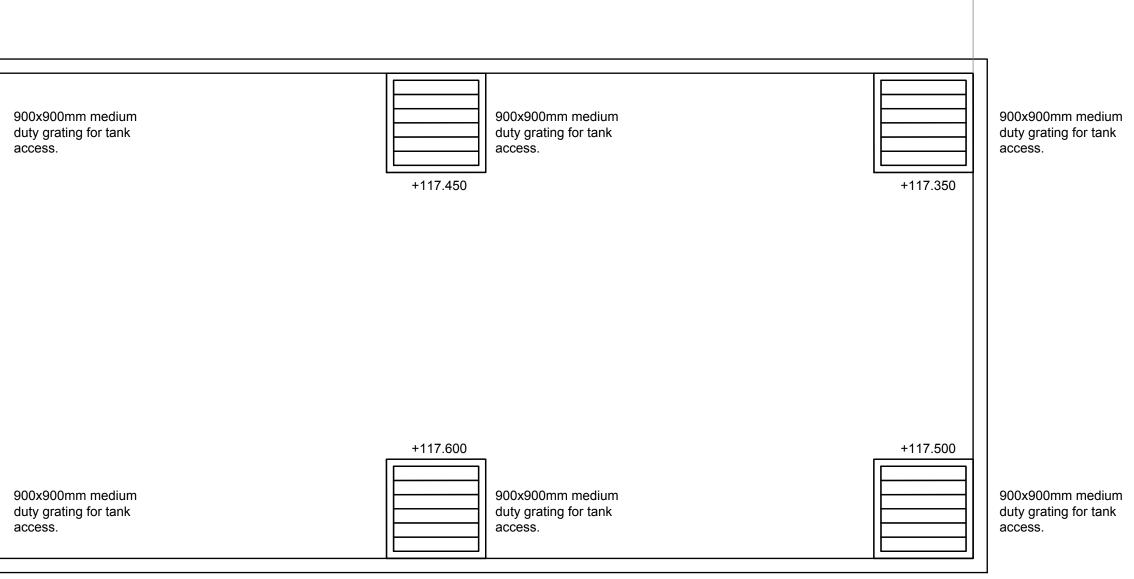

	115.40+	
		B
NOTFOR CONSTRUCTION	115.40+	

/UNITY at 14	PROPOSED MULTI DWELLING DEVELOPMENT	STORMWATER CONCEPT PLAN DETAIL SHEET		NOV 16	scale: nts@B1 DRAWN:	PROJ: 2658 CHECKED: RB	
	GLENHAVEN, NSW	FILE:	PLOTTED:	SHEET:	H-04	ļ	R

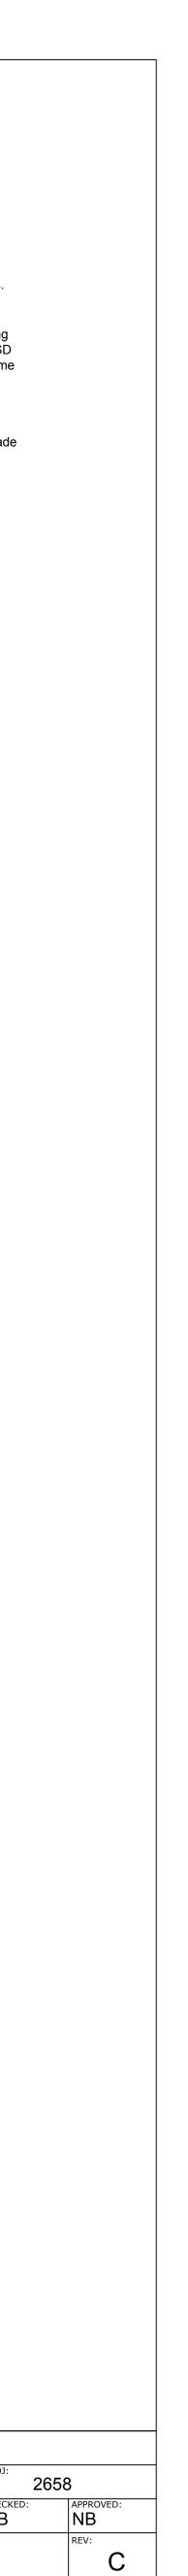


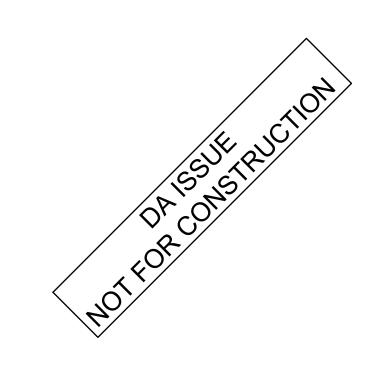

OSD Tank Signage





Mimimum Size - 187.5 mm x 250mm

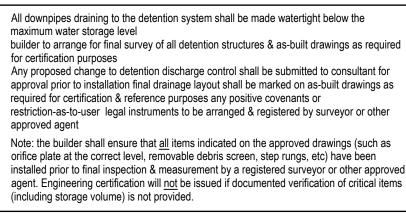


Note

Refer to Drains file for on site detention calculations

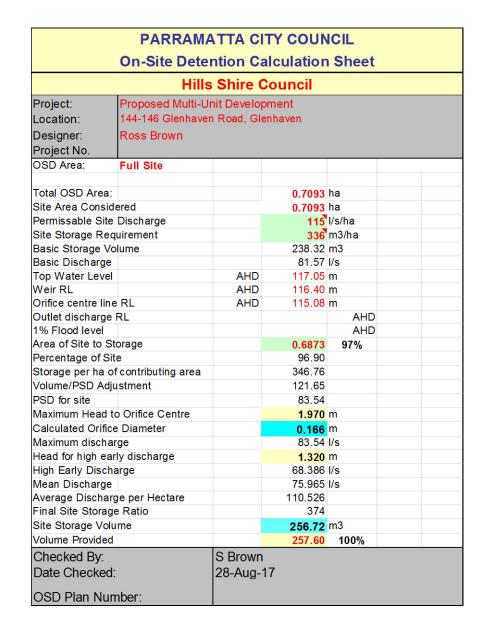


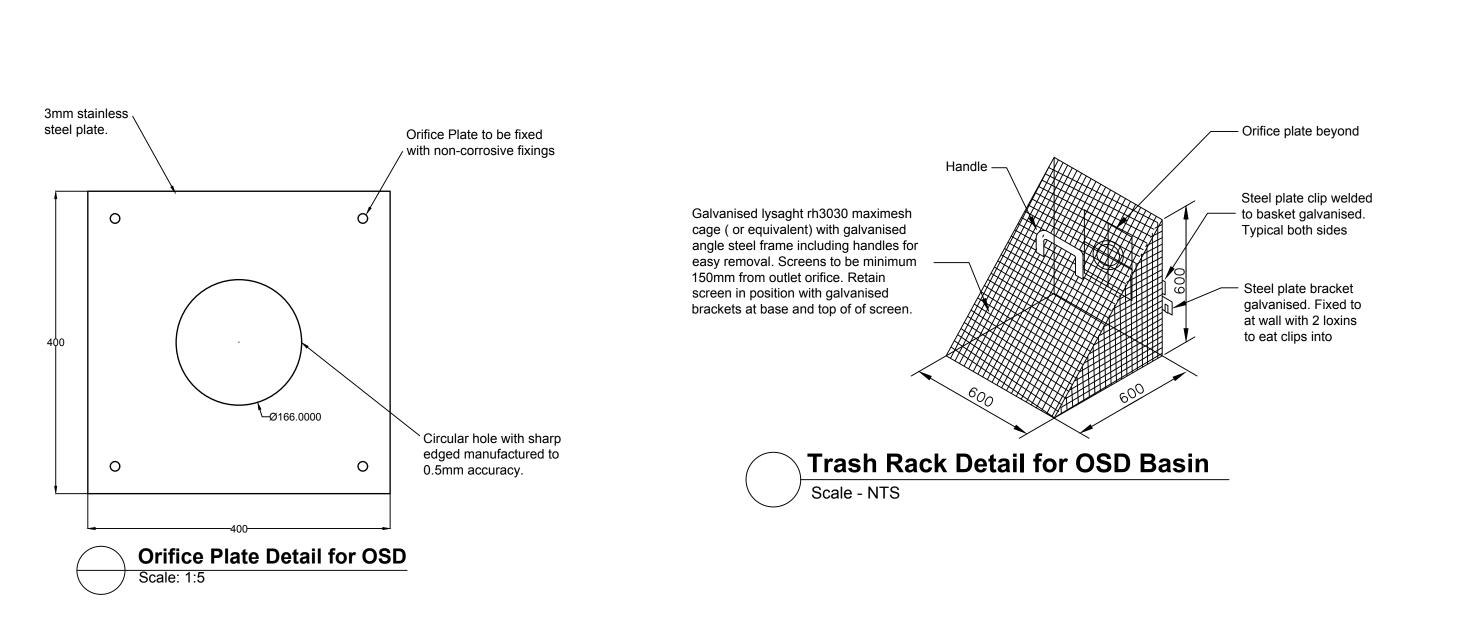


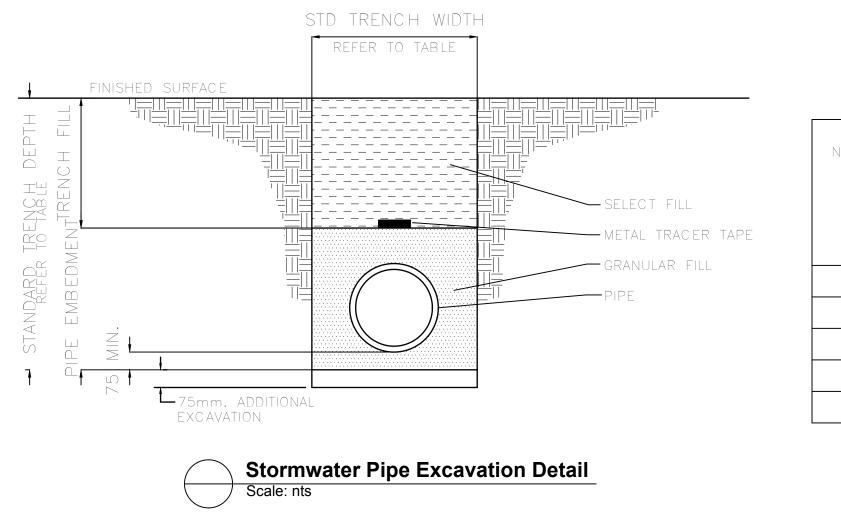


NOMINAI	STANDARD	STANDARD
SIZE	TRENCH WIDTH	ROADWA
(mm)	(mm)	(mm)
100	400	700
150	450	750
225	525	825
300	600	900
375	675	975

			PROJECT ARCHITECT	
С	Aug.2017	Council Amendments		CHITECTURE
В	Apr.2017	DA Submission		
A	Nov 2016	Preliminary	SYDNEY	MELBOURNE
REV	DATE	NOTATION/AMENDMENT		
	DO NOT	SCALE DRAWINGS. CHECK ALL DIMENSIONS ON SITE.	612-9922-2344	613-8676-0427
		FIGURED DIMENSIONS TAKE PRECEDENCE.		

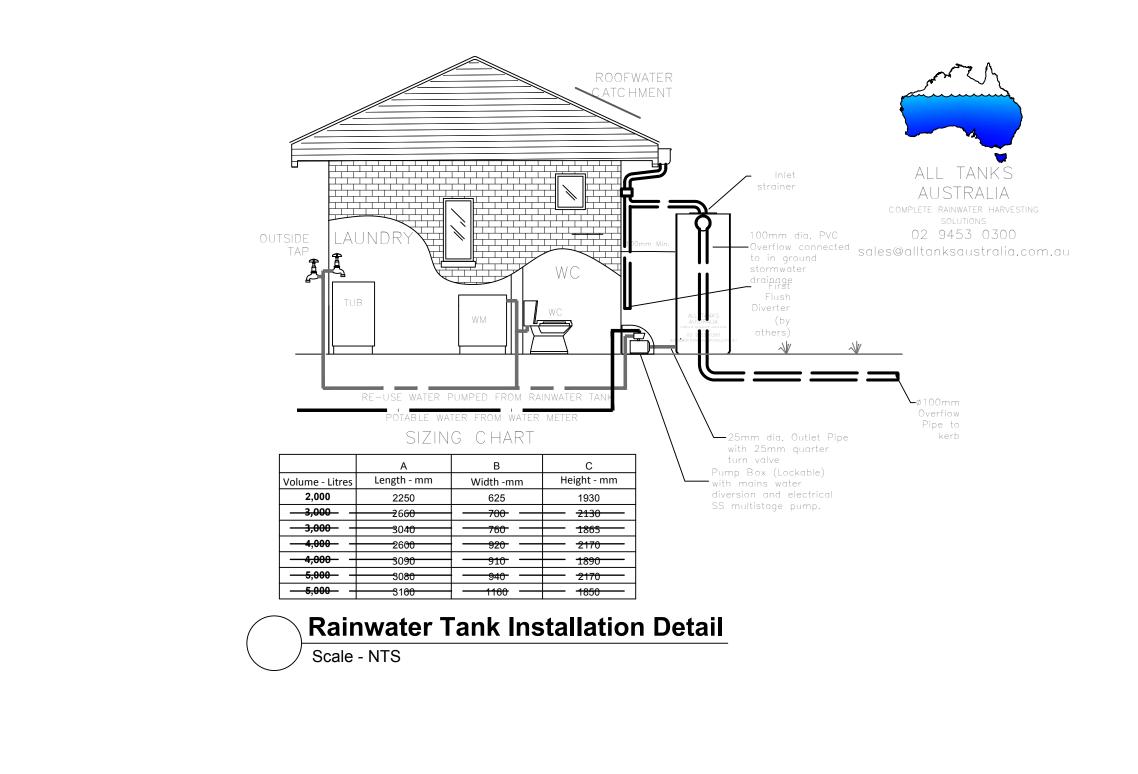

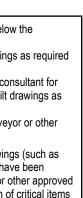



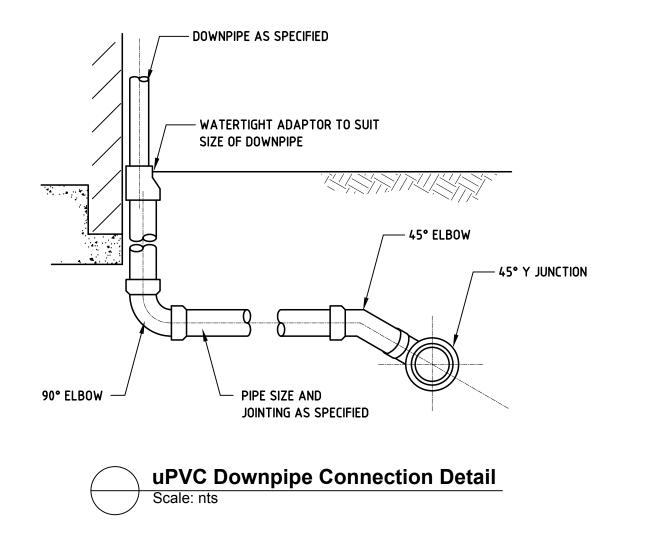


Discharge Inspect D spalling Inspect D sediment Inspect gra Inspect retu remove any

Inspect out blockage Check step Check fixing Storage Inspect ref


sediment i Inspect inte cracks or sp Inspect and blocking gra


HYDRAULIC CONSULTANT ABEL& BROWN PTY. LTD. 23 WARUNG STREET, YAGOONA, NSW 2199 M: 0403 390 810 T: 9709-5705 FAX: 9796-2272 E - mail@nevillebrown.com.au W - www.nevillebrown.com.au

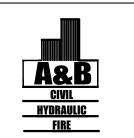

CLIENT:


CHRISTIAN BRETHEREN COMMUNITY SERVICES

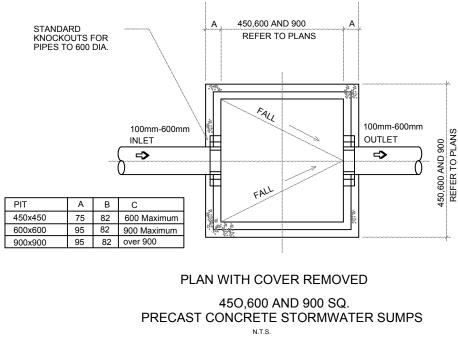


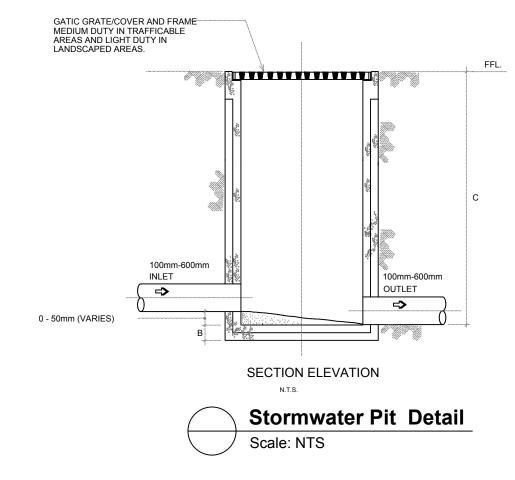

OSD Maintenance Requirements

Maintenance Action	Frequency	Responsibility	Procedure
scharge Control Pit			-
spect D walls for cracks or alling	Annually	Maintenance Contractor	Remove grate to inspect internal walls. Repair as required. Clear vegetation from external walls and repair as required.
spect D sump & remove any diment	Six monthly	Owner	Remove grate and screen. Remove sediment and check orifice and flap valve are clear.
spect grate for damage or blockage	Six monthly	Owner	Check both sides of the grate for corrosion, damage or blockage.
spect return pipe from storage & move any blockage.	Six monthly	Owner	Remove grate and screen. Ventilate underground storage if present. Open flap valve and remove any blockages in return line. Check for any sediment on upstream side of return line.
spect outlet pipe & remove any ockage	Six monthly	Maintenance Contractor	Remove grate and screen. Ventilate underground storage if present. Check orifice and remove any blockages in outlet pipe. Flush outlet pipe to confirm it drains freely. Check for sludge on upstream side of outlet pipe.
neck step irons for corrosion	Annually	Maintenance Contractor	Remove grate. Examine step irons and repair any corrosion or damage.
neck fixing of step irons is secure	Six monthly	Maintenance Contractor	remove grate and ensure fixings are secure prior to placing weight on step irons.
orage			
spect return pit & remove any diment in pit.	Annually	Maintenance Contractor	Remove Grate. Remove built up sediment.
spect internal return pit walls for acks or spalling	Annually	Maintenance Contractor	Remove grate to inspect internal walls. Repair as required. Clear vegetation from external walls and repair as required.
spect and remove any debris ocking grates of pits.	Six monthly	Owner	Remove blockages from grate and check if pit is blocked.

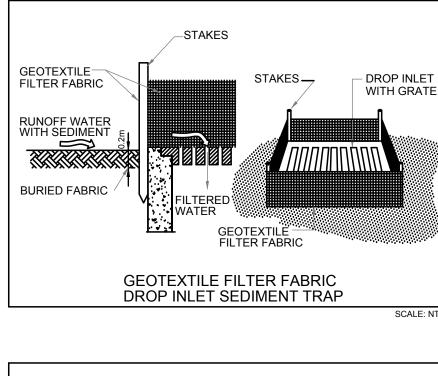

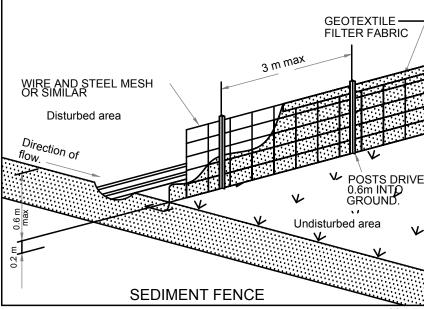

Sediment & Erosion Control Notes

1. The contractor shall implement all soil erosion and sediment control measures relating to a particular upstream catchment prior to stripping of topsoil from that catchment. Where it is necessary to undertake stripping in order to construct a sediment control device only sufficient ground shall be stripped to allow construction.

2. All soil erosion and sediment control measures shall be constructed and maintained as indicated on these drawings. Location and extent of soil and water management devices is diagrammatic only.

3. Conformity with this plan shall in no way reduce the responsibility of the contractor to protect against water damage during the course of the contract. It shall be the contractors responsibility to ensure that any necessary control is in place even though such control may not be shown on the plan.

4. The contractor shall inform all subcontractors and all employees of their responsibility in minimising the potential for soil erosion and pollution to downstream areas.

5. The contractor shall regularly maintain sediment and erosion control structures and desilt such structures prior to the reduction in capacity of 30% due to accumulated silt. The sediment shall be disposed of on site in a manner approved by the Liverpool Council Erosion and Sediment Control Policy.

6. Topsoil and spoil shall be stockpiled in non hazard areas and protected from surface runoff by diversion drains or similar. Stockpiles shall be surrounded on downstream sides by silt fencing. Stockpiles shall be suitable compacted to inhibit erosion. Where the stockpiling period exceeds four(4) weeks, the stockpile shall be seeded to encourage vegetation growth.

7. Topsoil shall be respread and stabilised as soon as possible.

shaping has occurred the contractor shall provide final rehabilitation within 20 days. 9. The contractor shall provide a turf strip behind all kerb and gutter at completion of footpath

formation. 10. The contractor shall maintain gross cover until all works have been completed, including the maintenance period, by frequent watering and mowing where required. Plant machinery

and vehicles shall not be driven over grassed areas unless on an approved haulage route. 11. Seed mixtures and stabilisation procedures shall be in accordance with the NSW

department of housing "Soil and water management for Urban Development ", January 1993 and construction specification.


12. The contractor shall provide inlet sediment traps at all pits during construction. 13. All drainage works shall be constructed and stabilised as quickly as possible to minimise


risk of erosion. 14. Vehicular traffic shall be controlled during construction confining access where possible to

proposed or existing road alignments plus 3 metres where necessary areas to be left undisturbed shall be marked off.


15. Site access shall be restricted to a nominated point. The construction of a shake down area may be required depending upon soil conditions.

PROJECT: TITLE: DA SUBMISSION STORMWATER CONCEPT PLAN **PROPOSED MULTI DWELLING DEVELOPMENT** DATE: SCALE: PROJ: NOV 16 nts@B1 DETAIL SHEET NO IN SET: DRAWN: CHECKED: SB RB 140-146 GLENHAVEN RD., 6 PLOTTED: SHEET: GLENHAVEN, NSW H-05

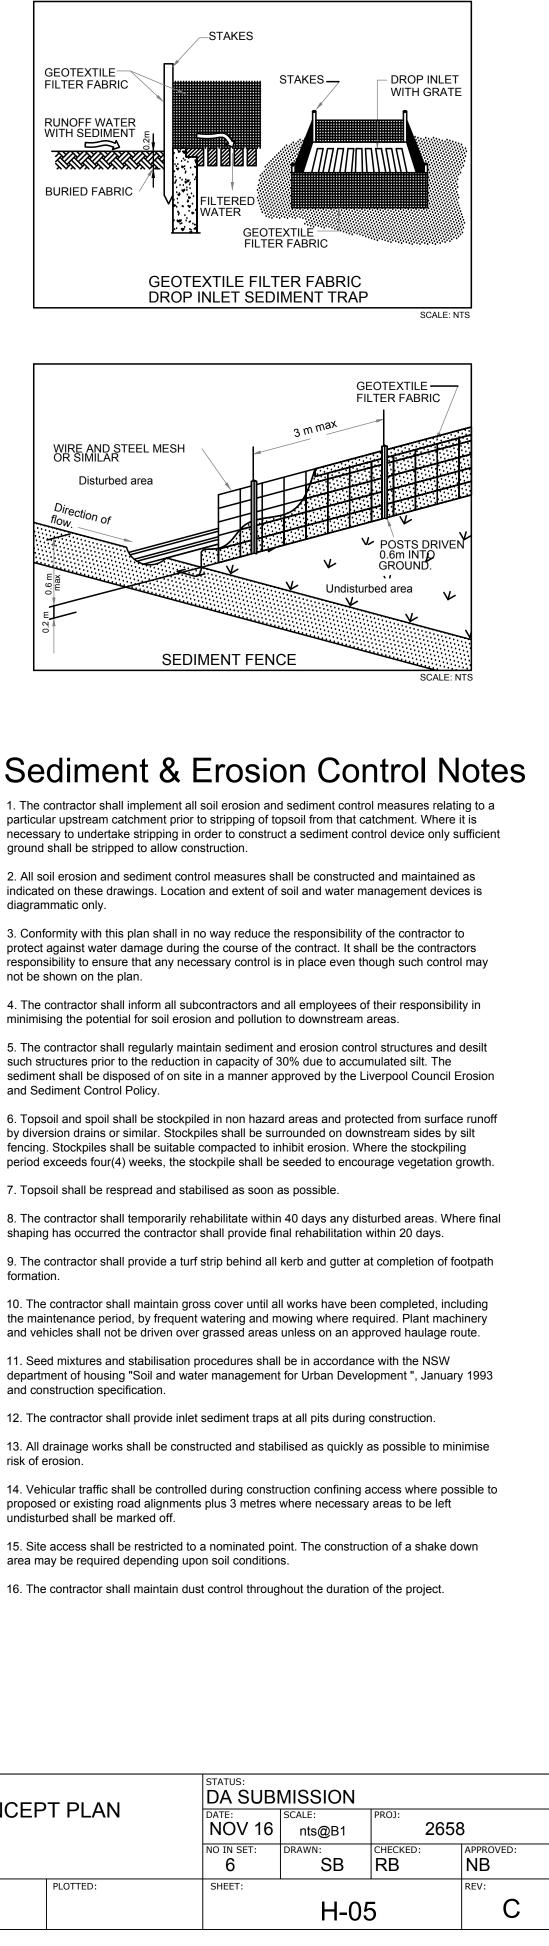


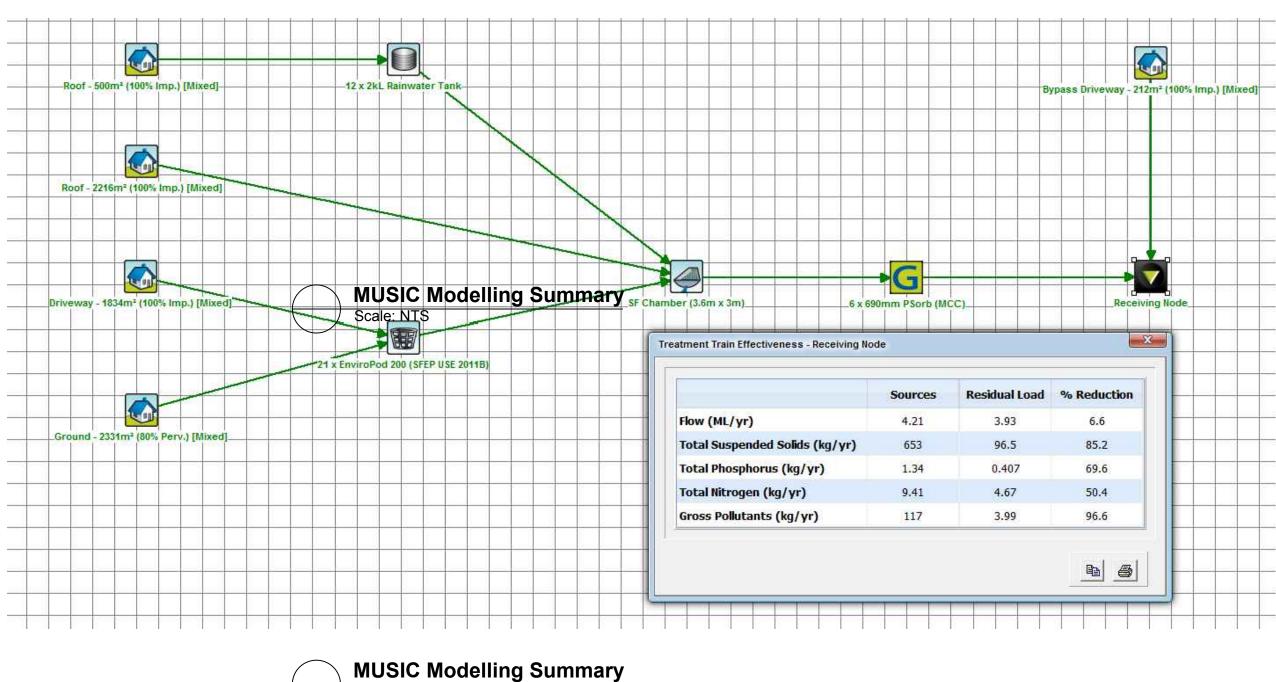




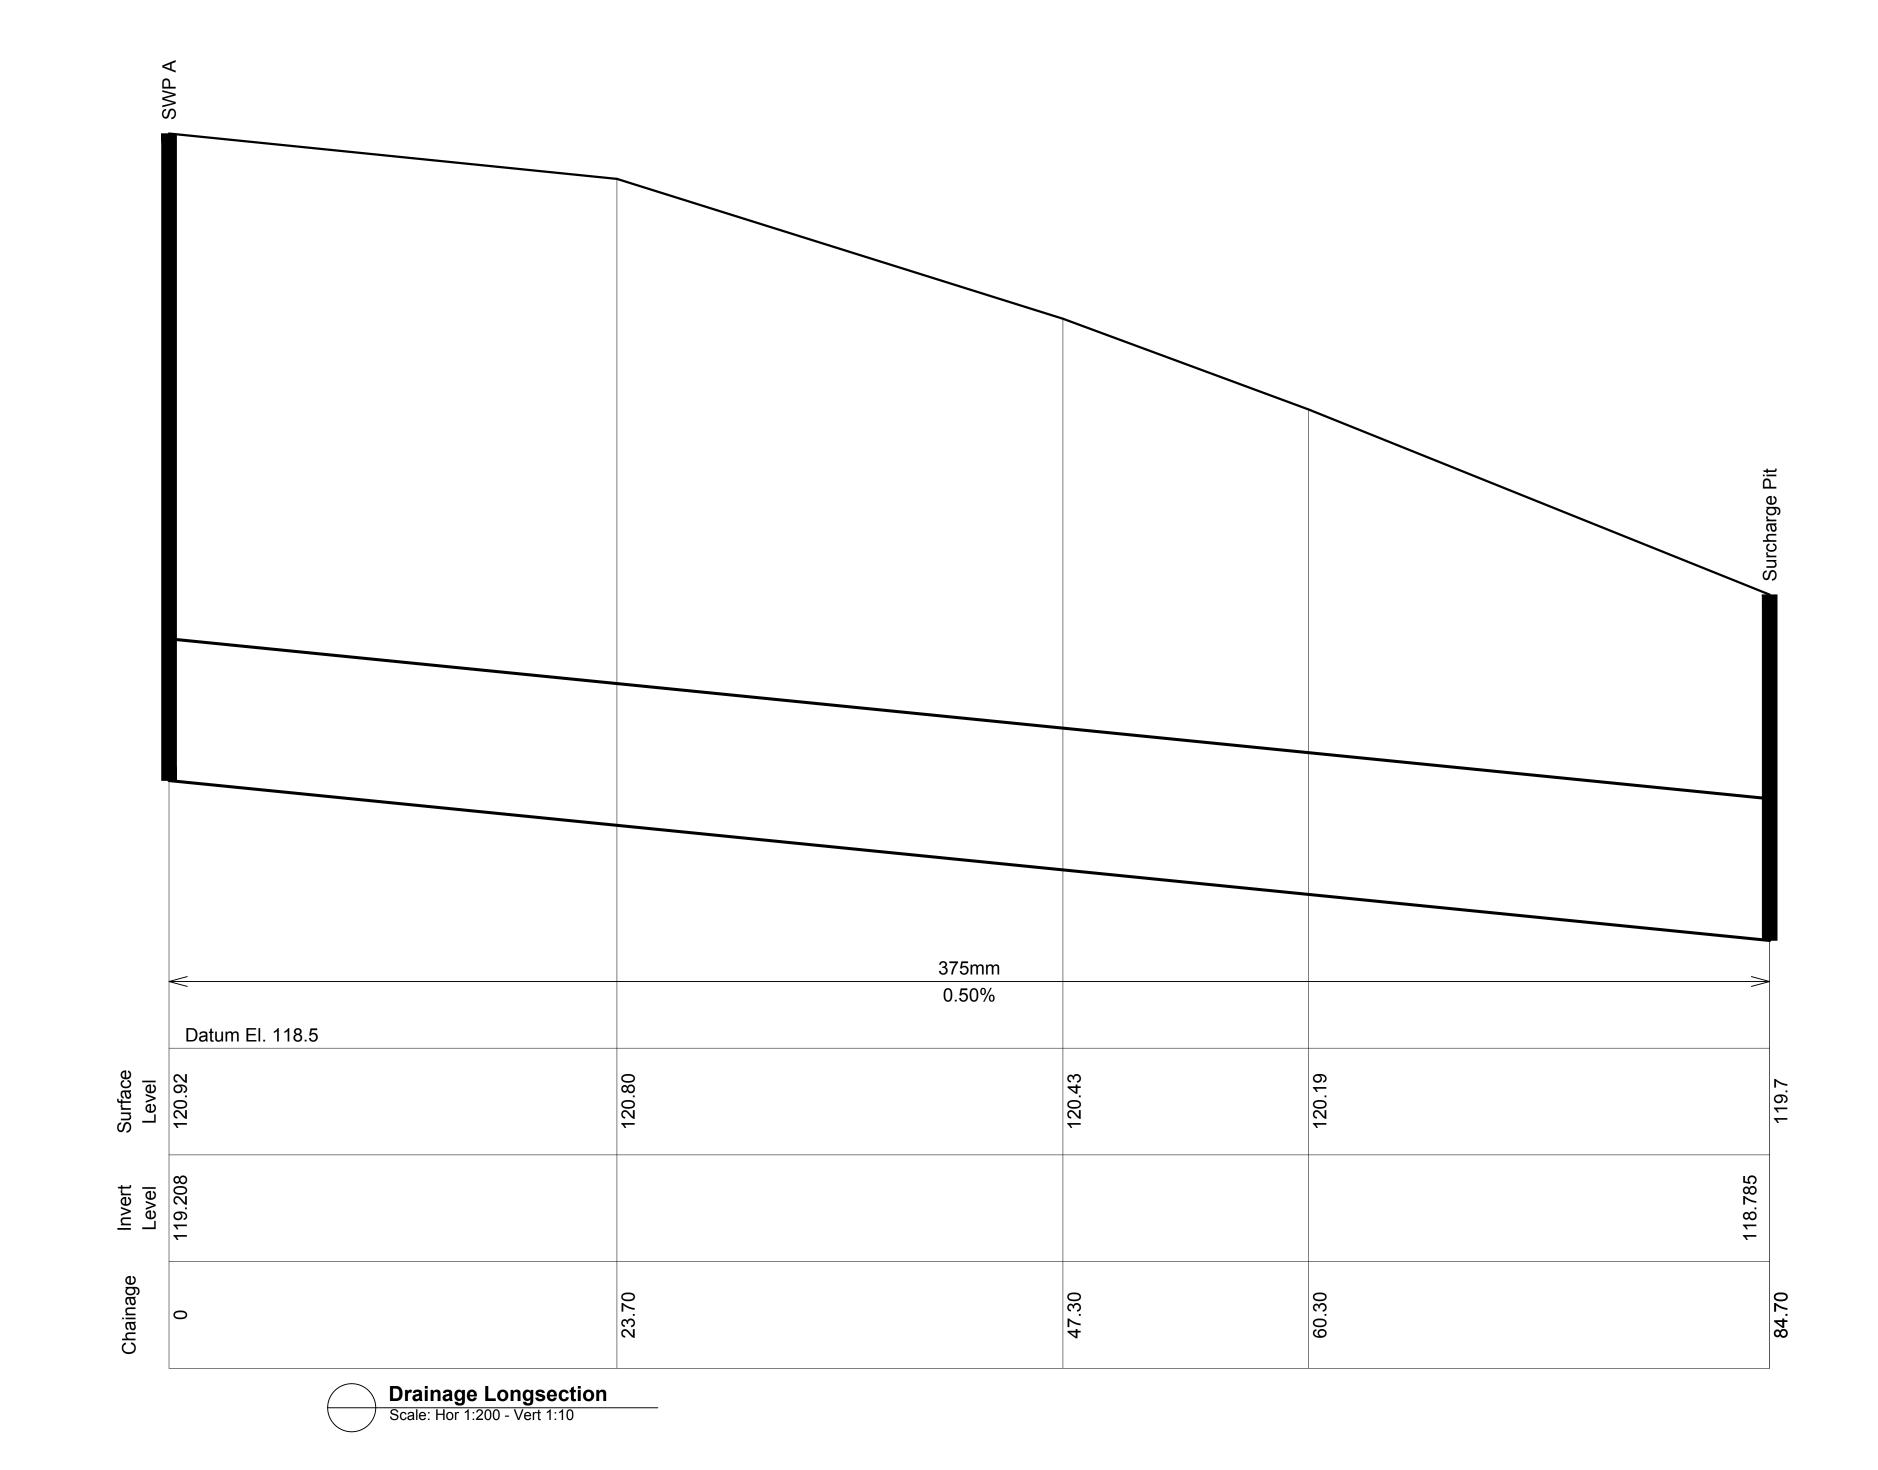

			PROJECT ARCHITECT	
С	Aug.2017	Council Amendments	NBRS ARCHI	IFCIURE
В	Apr.2017	DA Submission		
А	Nov 2016	Preliminary	SYDNEY	MELBOURNE
REV	DATE	NOTATION/AMENDMENT		613-8676-0427
	DO NOT	SCALE DRAWINGS. CHECK ALL DIMENSIONS ON SITE.	612-9922-2344	
		FIGURED DIMENSIONS TAKE PRECEDENCE.		

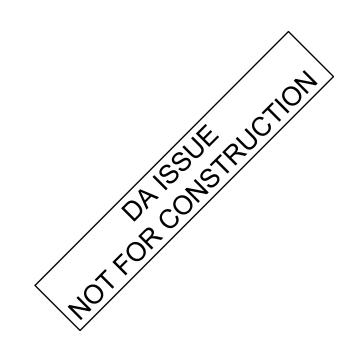

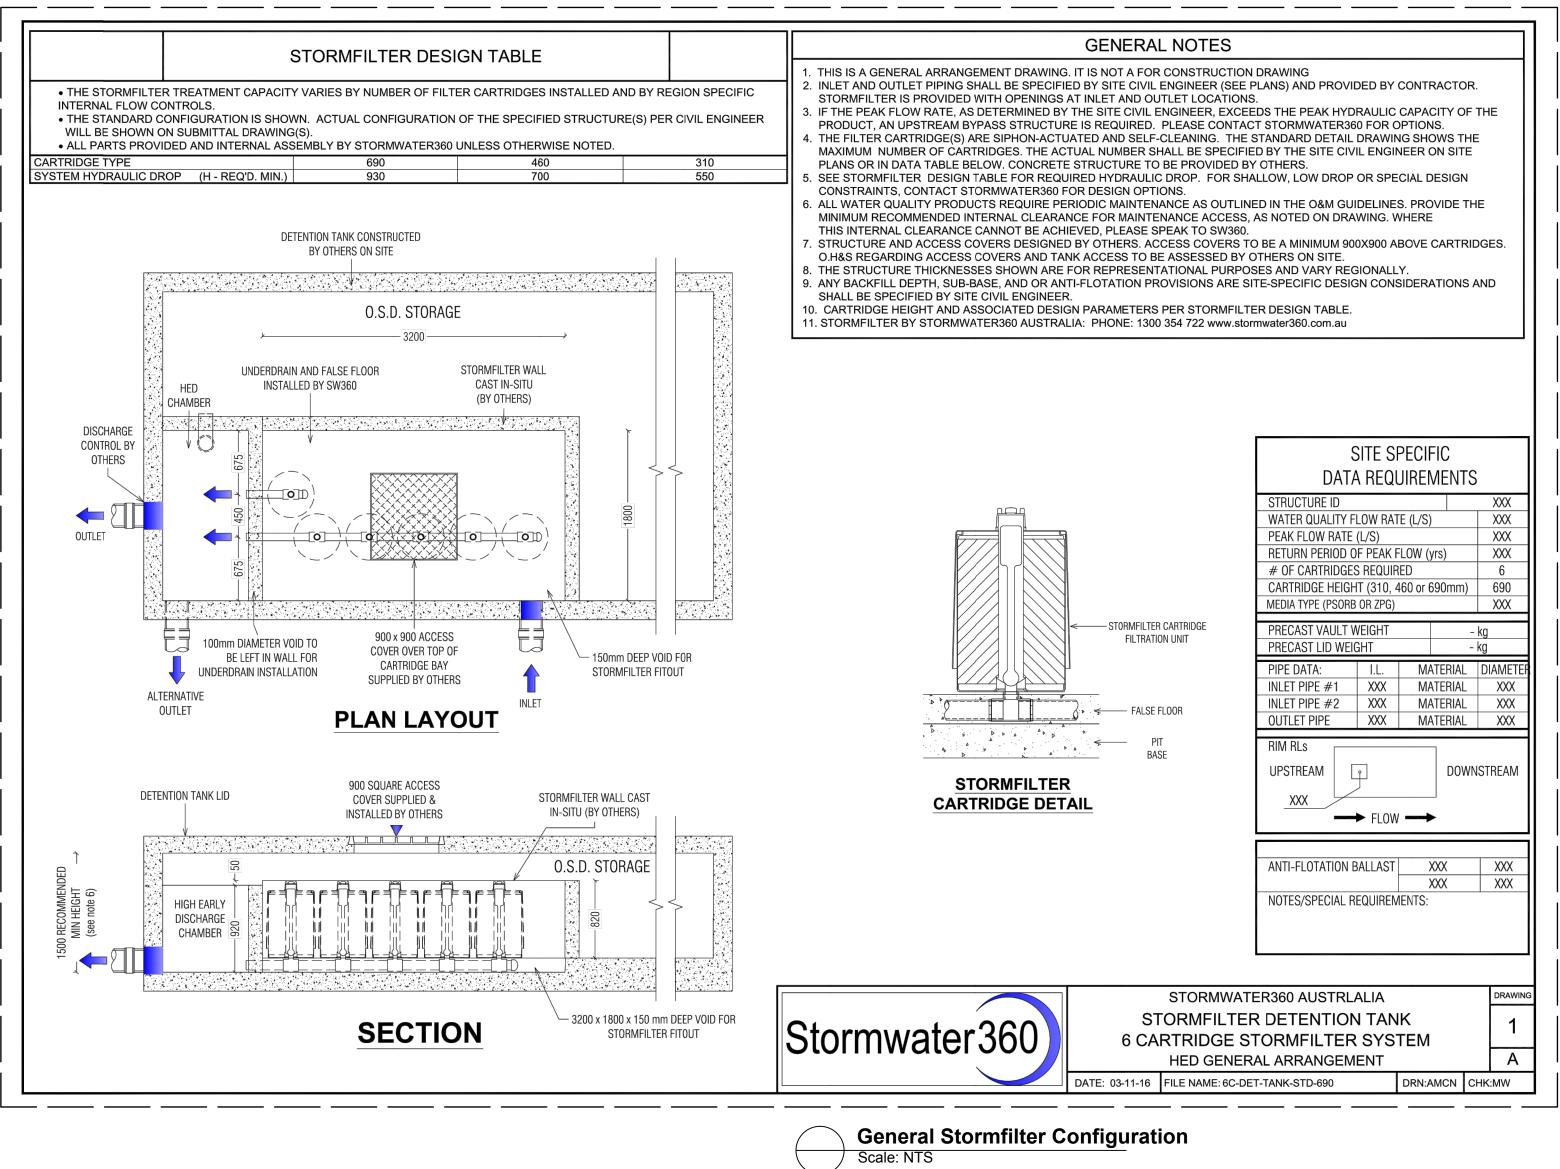

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HYDRAULIC CONSULTANT



CLIENT:

MUNITY	140-146 GLENHAVEN RD.,	TITLE: STORMWATER CONCEPT PLAN DETAIL SHEET		DATE: NOV 16	as shown	PROJ: 2 CHECKED: RB
		FILE:	PLOTTED:	SHEET:	H-06	6

